


PV SYSTEM SUMMARY	
TOTAL STC DC SYSTEM SIZE	2379.52 kW
SOLAR MODULE MODEL	CANADIAN SOLAR BIFACIAL DC
SOLAR MODULE STC DC RATING	440 W
SOLAR MODULE INFO	83.9" x 41.3" x 1.2", 62.6 lbs
SOLAR MODULE COUNT	5,408
RACKING SYSTEM	GROUND MOUNT RACKING
PITCH OF ARRAY	20°
INVERTER MODEL	16 x CPS SCH125KTL-DO/US-600 INVERTER
ARRAY AZIMUTH	180°
PANEL CLEARANCE	3'
INTERCONNECTION VOLTAGE	13.2kV, 3-PHASE(N.G.)

LEGEND	
	SOLAR MODULE
	TRANSFORMER PAD
	ACCESS ROAD
	EXISTING POLE
	INTERCONNECTION RUN
	DISTRIBUTION LINE
	FENCE

2 PV SYSTEM OVERVIEW
Scale: N.T.S.

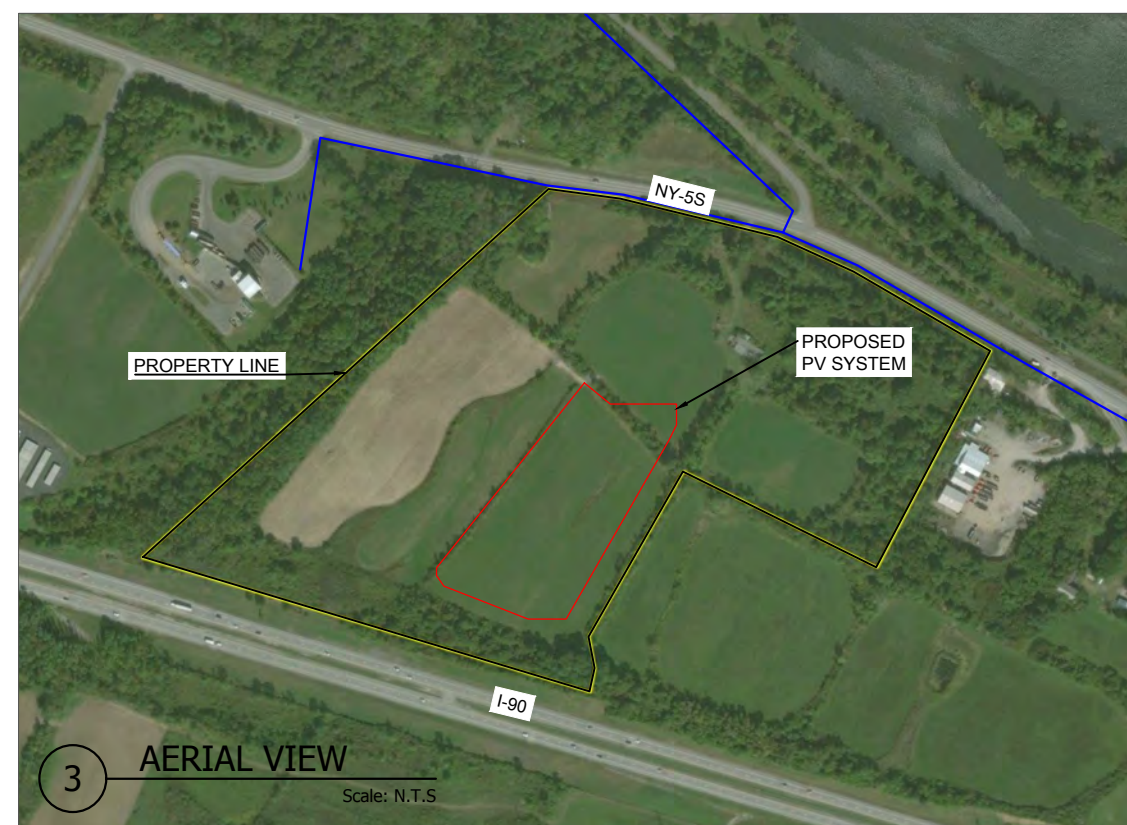

General Notes

THE INSTALLATION OF PV SYSTEM SHALL BE IN ACCORDANCE WITH THE MOST RECENT NATIONAL ELECTRIC AND BUILDING CODES AND STANDARDS, AS AMENDED BY JURISDICTION

ELECTRICAL STAMP AREA

THIS INFORMATION IS CONFIDENTIAL AND PROPRIETARY TO SOLAR LIBERTY ENERGY SYSTEMS, INC. PLEASE DO NOT SHARE THIS WITH ANYONE UNLESS THERE IS A WRITTEN APPROVAL FROM SOLAR LIBERTY.

No.	Revision/Issue	Date
2	Layout Update	06/25/21
1	Layout Update	05/10/21
0	Original Site Plan	04/26/21

SOLARLIBERTY
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CERTIFIED
PV Installation Professional

Project Name and Address

NY-5S
Amsterdam, NY 12010

Drawn By CR	Checked By
Date 05/10/2021	Date
Scale AS NOTED	Sheet PV-S1